

NOTICE of FILING

LAND USE REQUEST AFFECTING THIS AREA

There is a development proposal for the property listed in this notice and shown on the attached map. The City is seeking input from neighbors on the proposal. If you have questions or comments about the proposal, contact the case manager.

Esta carta es un aviso sobre una propuesta de desarrollo para la propiedad enumerada y que se muestra en el mapa adjunto. La ciudad está buscando la opinión de los vecinos sobre la propuesta. Si tiene preguntas o comentarios sobre la propuesta, póngase en contacto con nosotros al 503-588-6213.

CASE NUMBER: Class 3 Site Plan Review / Class 2 Adjustment / Class 1 Adjustment Case No.

SPR-ADJ24-17

PROPERTY LOCATION: 1850 45th Ave NE, Salem OR 97305

NOTICE MAILING DATE: May 28, 2024

CONSIDERED:

PROPOSAL SUMMARY: Phased development of a new turf recreational field and new off-street parking

area.

COMMENT PERIOD: All written comments must be submitted to City Staff no later than <u>5:00</u>

p.m., TUESDAY, June 11, 2024. Please direct any questions and/or

comments to the Case Manager listed below. Comments received after the close of the comment period will not be considered. *Note: Comments submitted are public record. This includes any personal information provided in*

your comment such as name, email, physical address and phone number.

CASE MANAGER: Aaron Panko, Planner III, City of Salem Planning Division, 555 Liberty Street SE,

Room 305, Salem, Oregon 97301. Telephone: 503-540-2356; E-mail:

APanko@cityofsalem.net

NEIGHBORHOOD

ASSOCIATION:

Neighborhood associations are volunteer organizations of neighbors coming together to make neighborhoods the best they can be. They receive notice of la

together to make neighborhoods the best they can be. They receive notice of land use applications within their boundaries, and they often submit comments on the applications to the City. Neighborhood association meetings are open to everyone.

Contact your neighborhood association to get involved:

East Lancaster Neighborhood Association (ELNA), Susann Kaltwasser, Land Use

Chair; Phone: 503-363-3998; Email: skaltwasser@salemneighbors.org.

ACCESS: The Americans with Disabilities Act (ADA) accommodations will be provided on

request.

CRITERIA TO BE Salem Revised Code (SRC) Chapters 220.005(f)(3) – Class 3 Site Plan Review;

250.005(d)(1 and 2) - Class 1 and 2 Adjustments

Salem Revised Code (SRC) is available to view at this link:

http://bit.ly/salemorcode. Type in the chapter number(s) listed above to view the

applicable criteria.

PROPERTY OWNER(S):

East Salem Community Center, Evergreen Plaza Group LLC (Adam Wittenberg)

APPLICANT(S):

East Salem Community Center

Evergreen Plaza Group LLC (Adam Wittenberg)

PROPOSAL REQUEST:

A Class 3 Site Plan Review for the phased development of a new turf recreational field with associated field lighting, and paving an existing gravel off-street parking area, with the following Adjustments:

- 1) A Class 1 Adjustment to increase the maximum off-street parking allowance for a development site in SRC Chapter 806, Table 806-1, from 221 space to 224 spaces, an increase of three spaces or 1.4 percent; and
- 2) Class 2 Adjustments to eliminate the pedestrian connection requirement per SRC 800.065(a)(1) between a building entrance and three abutting streets, including Dutchman Street NE, Geneva Avenue NE, and Nicholas Street NE.

The subject property is approximately 13.23 acres in size, zoned RM-II (Multi-Family Residential) and RA (Residential Agriculture), and located at 1850 45th Avenue NE – 97305 (Marion County Assessor's map and tax lot numbers: 072W19AA / 04200).

APPLICATION PROCESS:

Following the close of the Public Comment Period, a decision will be issued and mailed to the applicant, property owner, affected neighborhood association, anyone who submitted written comments, and anyone who received notice of the land use request.

Failure to raise an issue in writing prior to the close of the Public Comment Period with sufficient specificity to provide the opportunity to respond to the issue, precludes appeal to the Land Use Board of Appeals (LUBA) on this issue. A similar failure to raise constitutional issues relating to proposed conditions of approval precludes an action for damages in circuit court.

MORE INFORMATION:

All documents and evidence submitted by the applicant are available on the City's online Permit Application Center at https://permits.cityofsalem.net. You can use the search function without registering and enter the permit number listed here: 24 107371. Paper copies can be obtained for a reasonable cost.

PLEASE PROMPTLY FORWARD A COPY OF THIS NOTICE TO ANY OTHER OWNER, TENANT OR LESSEE For more information about Planning in Salem:

http://www.cityofsalem.net/planning

It is the City of Salem's policy to assure that no person shall be discriminated against on the grounds of race, religion, color, sex, marital status, familial status, national origin, age, mental or physical disability, sexual orientation, gender identity and source of income, as provided by Salem Revised Code Chapter 97. The City of Salem also fully complies with Title VI of the Civil Rights Act of 1964, and related statutes and regulations, in all programs and activities. Disability-related modification or accommodation, including auxiliary aids or services, in order to participate in this meeting or event, are available upon request. Sign language and interpreters for languages other than English are also available upon request. To request such an accommodation or interpretation, contact the Community Development

Department at 503-588-6173 at least three business days before this meeting or event.

TTD/TTY telephone 503-588-6439 is also available 24/7

REQUEST FOR COMMENTS

Si necesita ayuda para comprender esta información, por favor llame 503-588-6173

REGARDING: Class 3 Site Plan Review / Class 2 Adjustment / Class 1 Adjustment

Case No. SPR-ADJ24-17

PROJECT ADDRESS: 1850 45th Ave NE, Salem OR 97305

AMANDA Application No.: 24-107371-PLN

COMMENT PERIOD ENDS: Tuesday, June 11, 2024, at 5:00 p.m.

SUMMARY: Phased development of a new turf recreational field and new off-street parking area.

REQUEST: A Class 3 Site Plan Review for the phased development of a new turf recreational field with associated field lighting, and paving an existing gravel off-street parking area, with the following Adjustments:

- 1) A Class 1 Adjustment to increase the maximum off-street parking allowance for a development site in SRC Chapter 806, Table 806-1, from 221 space to 224 spaces, an increase of three spaces or 1.4 percent; and
- 2) Class 2 Adjustments to eliminate the pedestrian connection requirement per SRC 800.065(a)(1) between a building entrance and three abutting streets, including Dutchman Street NE, Geneva Avenue NE, and Nicholas Street NE.

The subject property is approximately 13.23 acres in size, zoned RM-II (Multi-Family Residential) and RA (Residential Agriculture), and located at 1850 45th Avenue NE 97305 (Marion County Assessor's map and tax lot numbers: 072W19AA / 04200).

The Planning Division is interested in hearing from you about the attached proposal. Staff will prepare a Decision that includes consideration of comments received during this comment period. We are interested in receiving pertinent, factual information such as neighborhood association recommendations and comments of affected property owners or residents. The complete case file, including all materials submitted by the applicant and any applicable professional studies such as traffic impact analysis, geologic assessments, and stormwater reports, are available upon request.

Comments received by 5:00 p.m., TUESDAY, June 11, 2024, will be considered in the decision process. Comments received after this date will be not considered. Comments submitted are <u>public record</u>. This includes any personal information provided in your comment such as name, email, physical address and phone number. <u>Mailed comments can take up to 7 calendar days to arrive at our office. To ensure that your comments are received by the deadline, we recommend that you e-mail your comments to the Case Manager listed below.</u>

<u>CASE MANAGER:</u> Aaron Panko, Planner III, City of Salem, Planning Division; 555 Liberty St SE, Room 305, Salem, OR 97301; Phone: 503-540-2356; E-Mail: APanko@cityofsalem.net.

For information about Planning in Salem, please visit: http://www.cityofsalem.net/planning

PLEASE CHECK THE FOLLOWING THAT APPLY:

reviewed the proposal and have no objections to it. reviewed the proposal and have the following comments:	
Nome/Ageney	
Name/Agency:	
Address:	
Phone:	
Email:	
Date:	

IMPORTANT: IF YOU MAIL COMMENTS, PLEASE FOLD AND RETURN THIS POSTAGE-PAID FORM




BUSINESS REPLY MAIL FIRST-CLASS MAIL PERMIT NO. 1508 SALEM, OR

POSTAGE WILL BE PAID BY ADDRESSEE

PLANNING DIVISION CITY OF SALEM RM 305 555 LIBERTY ST SE SALEM OR 97301–9907 NO POSTAGE NECESSARY IF MAILED IN THE UNITED STATES


լանալույնին-ակարհրդիկինությունների ակարարակ**ն**

Vicinity Map 1850 45th Avenue NE

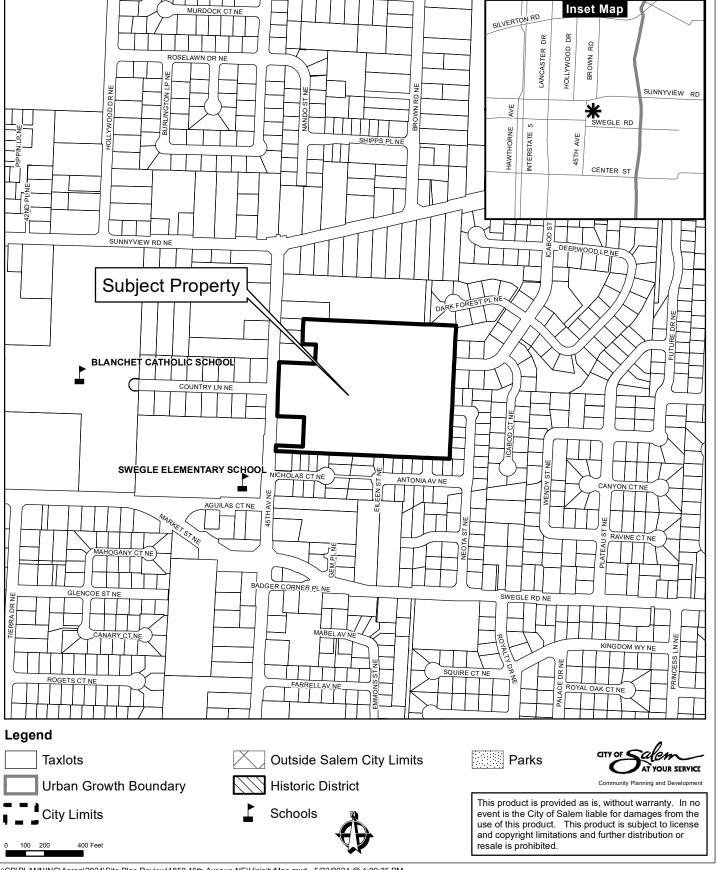


EAST SALEM COMMUNITY CENTER TURF FIELD & PARKING LOT

PRELIMINARY PLANS FOR SITE PLAN REVIEW APPLICATION

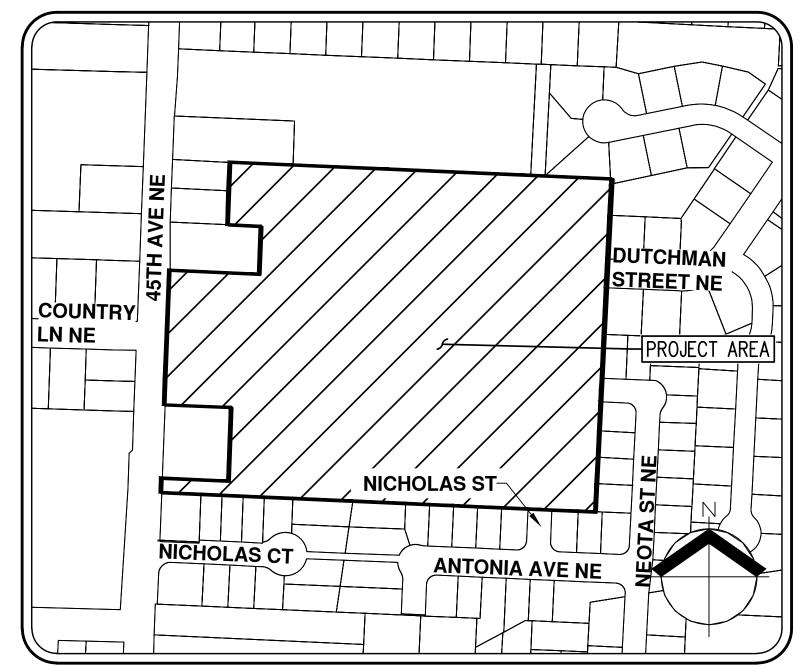

VICINITY MAP

		<u>LE</u>	<u>GEND</u>		
<u> </u>	<u>EXISTING</u>	PROPOSED		EXISTING	PROPOSE
DECIDUOUS TREE	\odot	\bigcirc	STORM DRAIN CLEAN OUT	0	•
CONFEDENCE TREE	M		STORM DRAIN CATCH BASIN		
CONIFEROUS TREE	M		STORM DRAIN AREA DRAIN		
FIRE HYDRANT	Ω	A	STORM DRAIN MANHOLE	© _	
WATER BLOWOFF	Ŷ	†	GAS METER	<u> </u>	
WATER METER			GAS VALVE	D	
WATER VALVE	M	H	GUY WIRE ANCHOR	_	-
DOUBLE CHECK VALVE	lacktriangledown	E	UTILITY POLE	-0-	-
AIR RELEASE VALVE	රු	₽	POWER VAULT	P	P
SANITARY SEWER CLEAN OU	_	•	POWER JUNCTION BOX		A
SANITARY SEWER MANHOLE	0	•	POWER PEDESTAL COMMUNICATIONS VAULT		
SIGN	- 0-		COMMUNICATIONS JUNCTION BOX	C	C
STREET LIGHT MAILBOX	☆ [MB]	₩ [MB]	COMMUNICATIONS RISER	\triangle	•
BOUNDARY LINE					
BOUNDARY LINE					
PROPERTY LINE					
CENTERLINE					
DITCH		>	> > -	>	->
CURB					
EDGE OF PAVEMENT					
EASEMENT					
FENCE LINE		· · · · · · ·		0 0	
GRAVEL EDGE					
POWER LINE		- — PWR — — —	— — PWR — — PWR —		DWD
OVERHEAD WIRE		OHW			OHW
COMMUNICATIONS LINE		— COM — — —			СОМ ———
FIBER OPTIC LINE		— CFO — — —	CF0 CF0 -		CFO
GAS LINE		- — GAS — — -	— GAS — GAS —	GAS	— GAS ———
STORM DRAIN LINE			— stm — — stm —		STM
SANITARY SEWER LINE		SAN	— — SAN — — — SAN-		SAN
WATER LINE		WAT	wat wat _		WAT

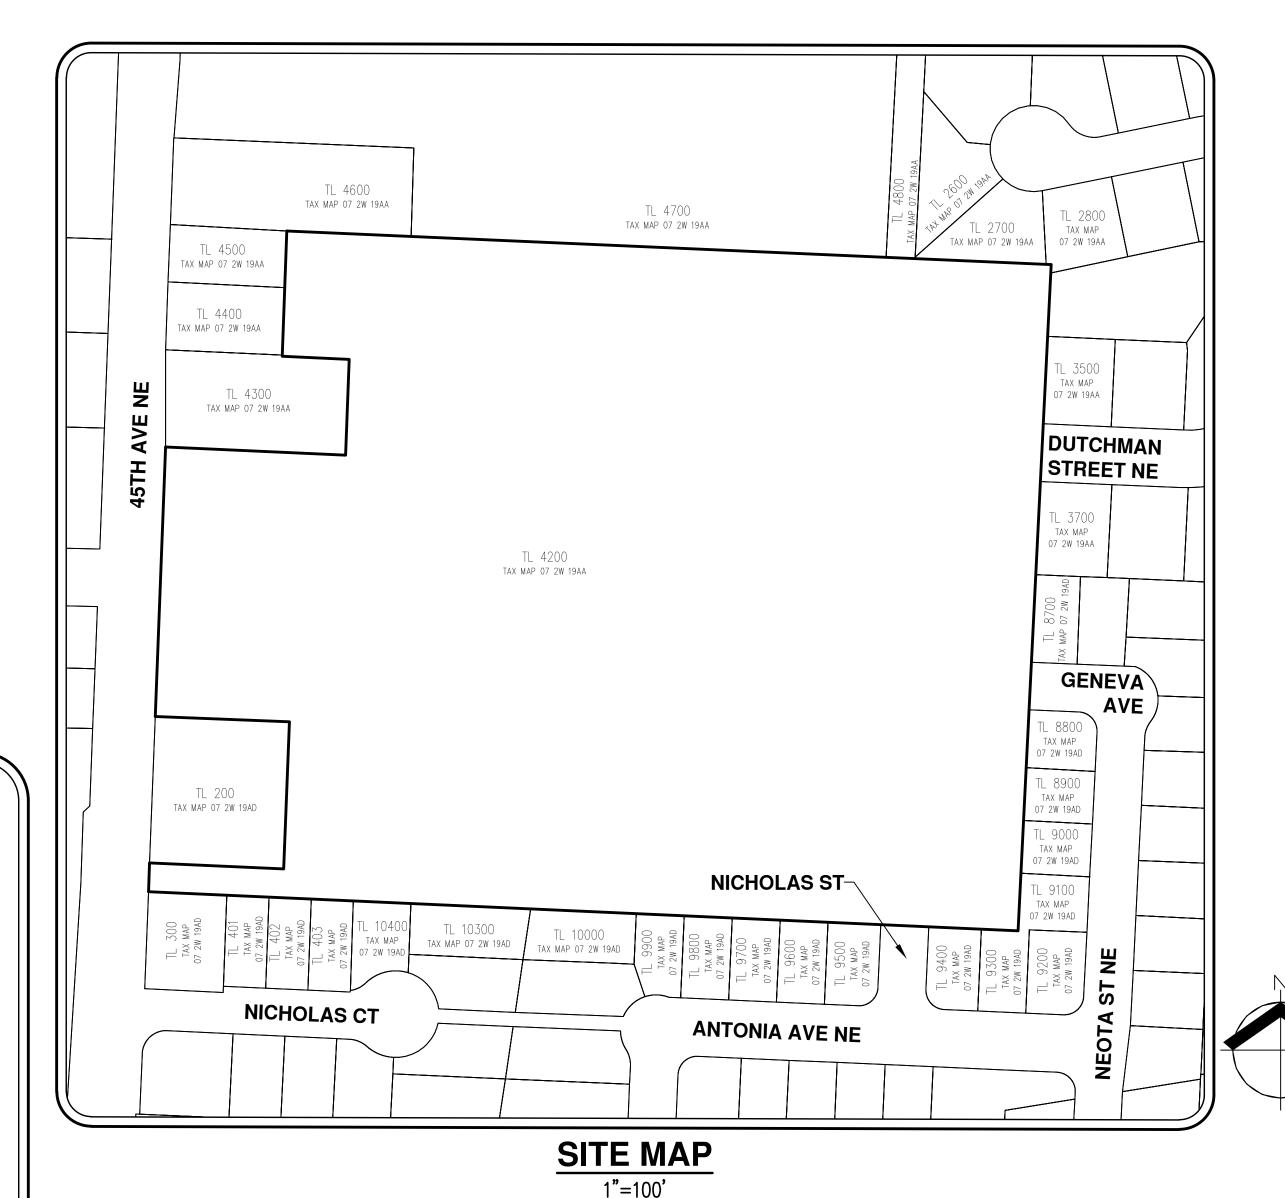

SHEET INDEX

P01 COVER SHEET

C002 EXISTING CONDITIONS

PO3 PRELIMINARY PHASING PLAN

PO4 PRELIMINARY SITE AND SURFACING PLAN

PO5 PRELIMINARY TURF FIELD SECTION

PO6 PRELIMINARY GRADING AND UTILITY PLAN

P07 PRELIMINARY TREE CONSERVATION PLAN

PO8 PRELIMINARY DETAILED TREE TABLE

DDELIMINADY LANDSCADE DLAN

PO9 PRELIMINARY LANDSCAPE PLAN

P10 NON-DISCRETIONARY STORMWATER SITE PLAN

APPLICANT

BLANCHET COMMUNITY FOUNDATION CONTACT: DANA NORTH 1850 45TH AVENUE NE SALEM, OR 97305

PROJECT LOCATION / DESCRIPTION:

MARION COUNTY TAX MAP 07 2W 19AA TAX LOT 4200 CITY OF SALEM, OREGON

ADDRESS

1850 45TH AVE NE, SALEM, OR 97305

CIVIL ENGINEERING / SURVEYING LAND USE PLANNING / LANDSCAPE ARCHITECTURE FIRM

AKS ENGINEERING & FORESTRY, LLC
LAND USE PLANNING CONTACT: ZACH PELZ, AICP
ENGINEERING CONTACT: AUSTIN COLE, PE
3700 RIVER RD N, STE 1
KEIZER, OR 97303
PH: 503.400.6028
WWW.AKS-ENG.COM

TYPE OF APPLICATION:

CLASS 3 SITE PLAN REVIEW

EXISTING LAND USE:

EXISTING COMMUNITY CENTER BUILDING AND ASSOCIATED INFRASTRUCTURE.

SITE AREA


±13.23 ACRES

PROJECT PURPOSE:

CONSTRUCTION OF A RECREATIONAL ARTIFICIAL TURF FIELD IN THE CITY OF SALEM'S RM—II ZONING DISTRICT AND CONSTRUCTION OF PARKING IMPROVEMENTS IN THE CITY OF SALEM'S RA ZONING DISTRICT.


VERTICAL DATUM:

ELEVATIONS ARE BASED ON NGS BENCHMARK QE1447, LOCATED AT THE JUNCTION OF LANCASTER DRIVE AND WOLVERINE STREET. ELEVATION = 202.94 FEET (NAVD88) THEN ADJUSTED TO NGVD29 WITH A VERTCON SHIFT OF -3.36 FEET, SETTING THE NGVD29 ELEVATION AT 199.58 FEET.

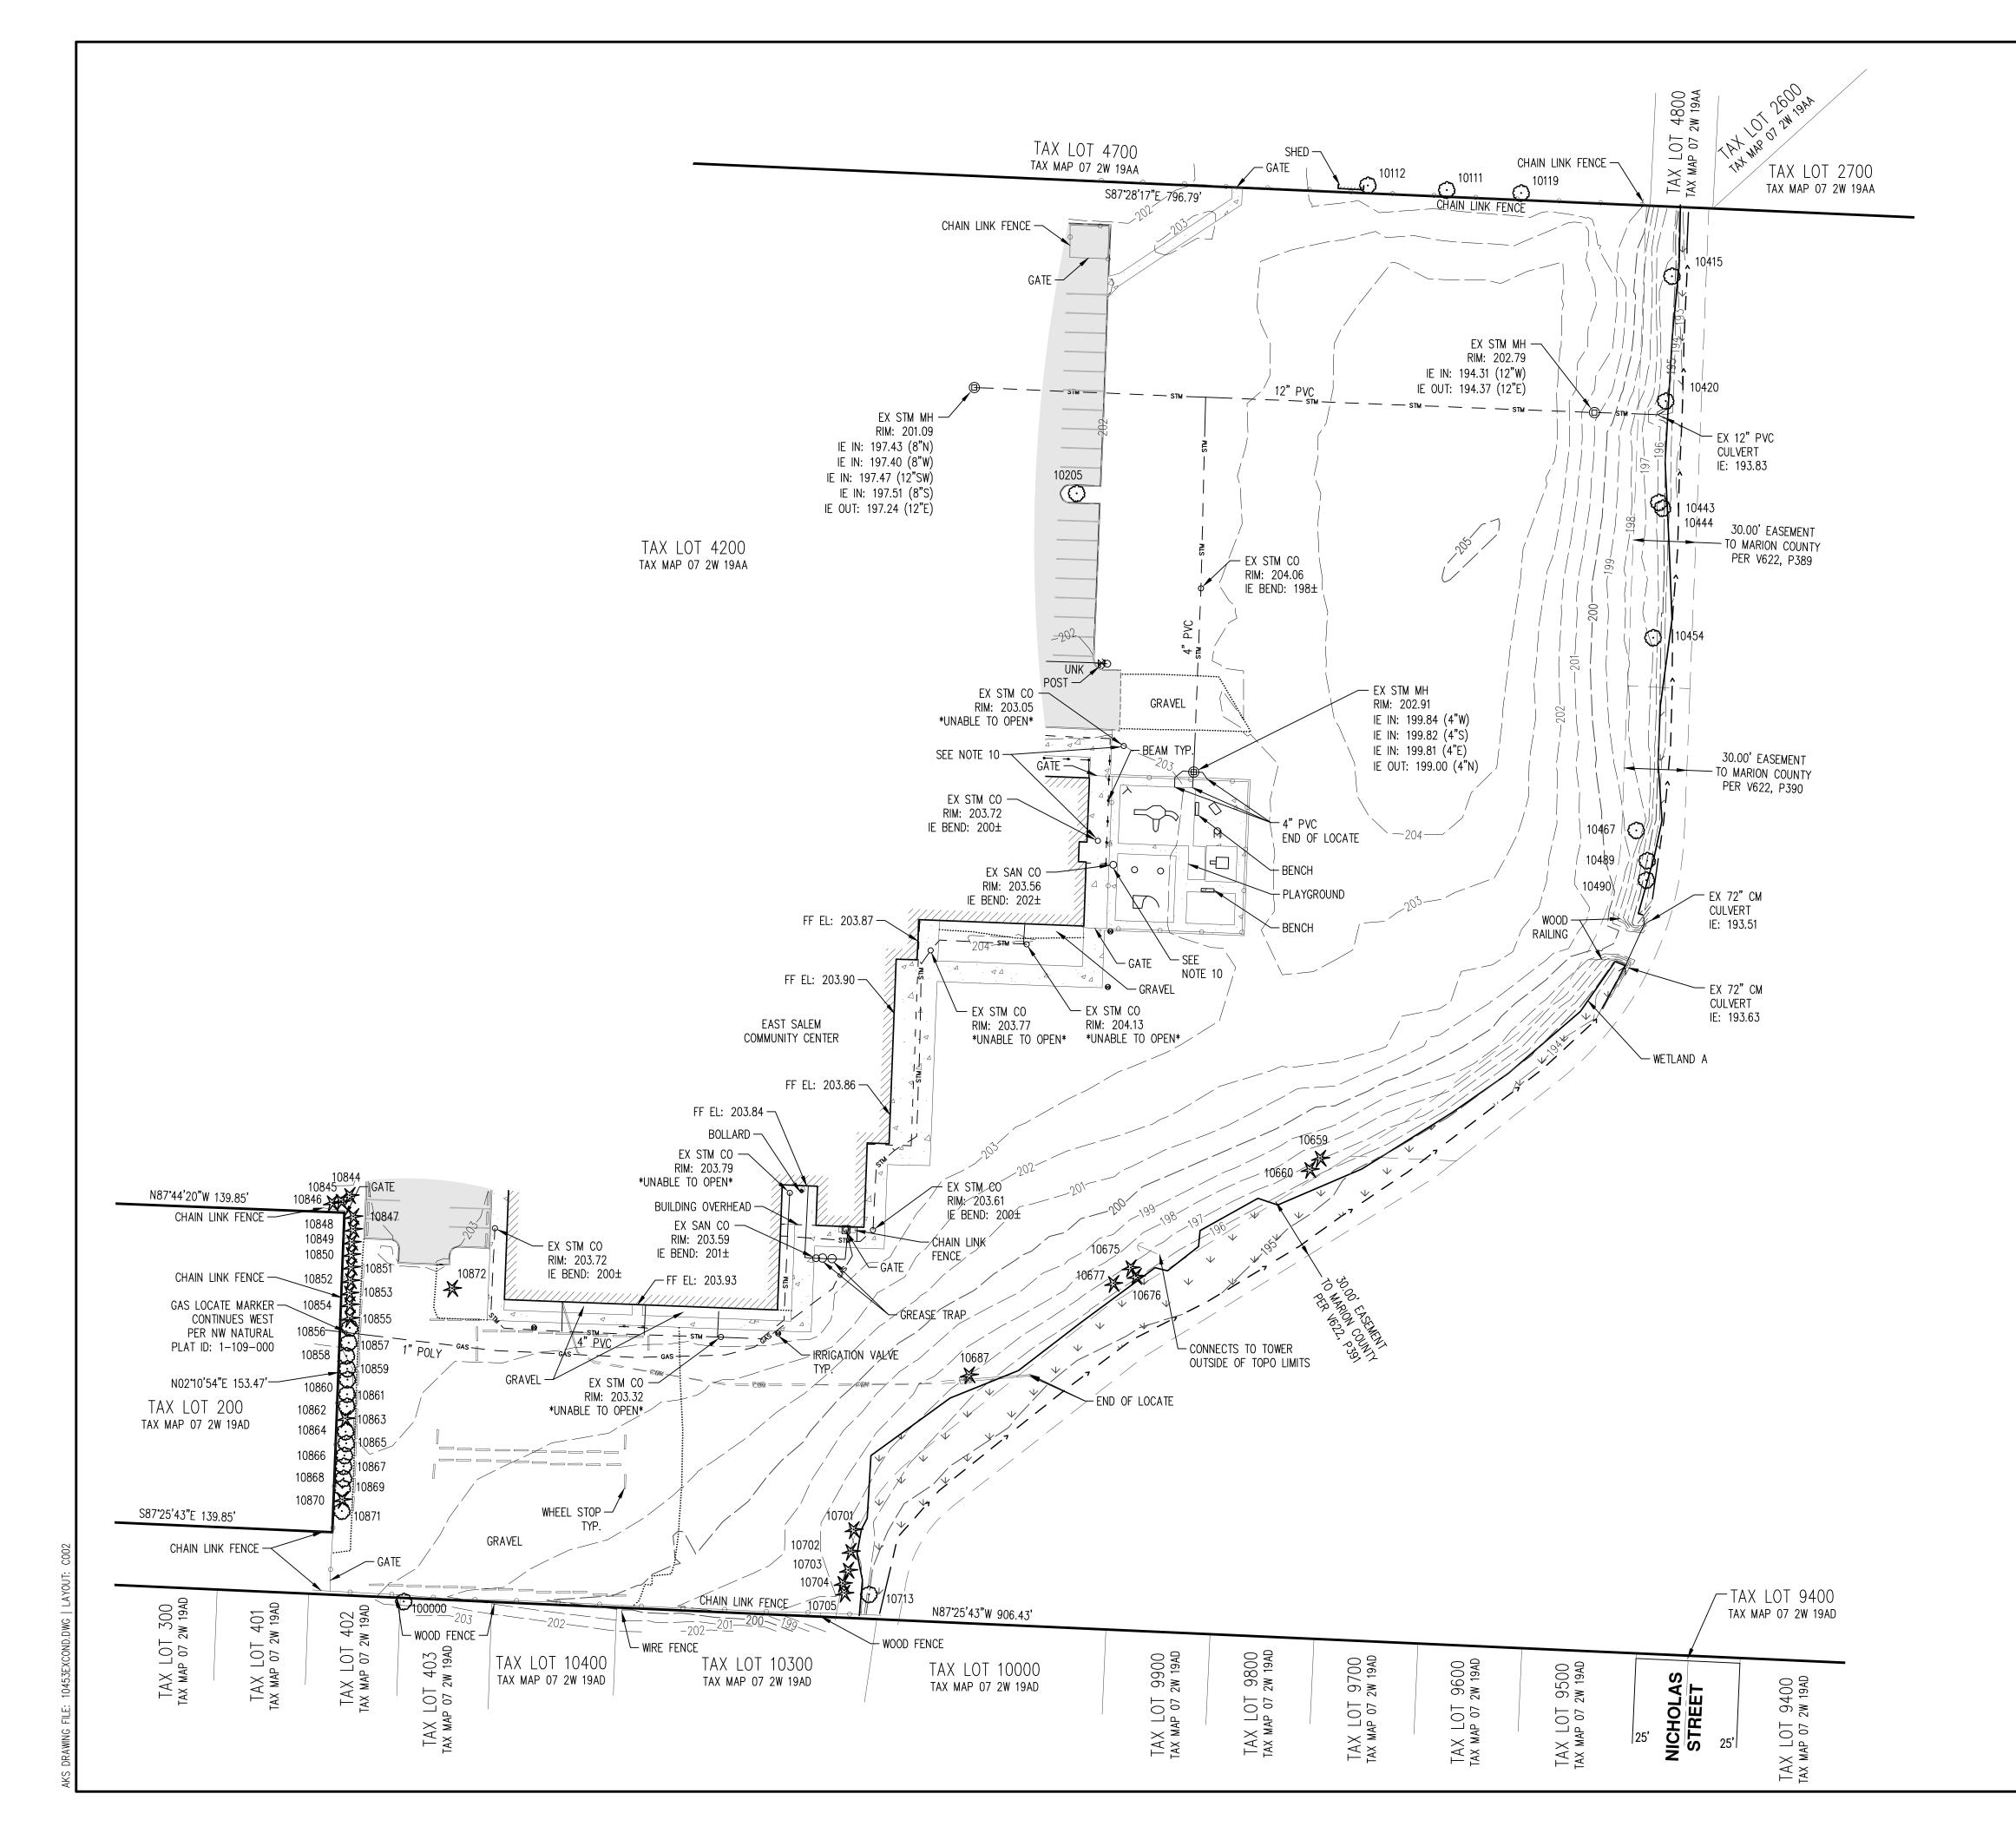

- . UTILITIES SHOWN ARE BASED ON UNDERGROUND UTILITY LOCATE MARKINGS PROVIDED PER PRIVATE LOCATING COMPANY MARK IT OUT LLC. THE SURVEYOR MAKES NO GUARANTEE THAT THE UNDERGROUND LOCATES REPRESENT THE ONLY UTILITIES IN THE AREA. CONTRACTORS ARE RESPONSIBLE FOR VERIFYING ALL EXISTING CONDITIONS PRIOR TO BEGINNING CONSTRUCTION.
- 2. FIELD WORK WAS CONDUCTED DECEMBER, 2023.
- 3. HORIZONTAL DATUM: OREGON COORDINATE REFERENCE SYSTEM, SALEM ZONE. DISTANCES SHOWN ARE IN INTERNATIONAL FOOT GROUND VALUES.
- 4. VERTICAL DATUM: ELEVATIONS ARE BASED ON NGS BENCHMARK QE1447, LOCATED AT THE JUNCTION OF LANCASTER DRIVE AND WOLVERINE STREET. ELEVATION = 202.94 FEET (NAVD88) THEN ADJUSTED TO NGVD29 WITH A VERTCON SHIFT OF -3.36 FEET, SETTING THE NGVD29 ELEVATION AT 199.58 FEET.
- 5. CONTOUR INTERVAL IS 1.00 FOOT.
- 6. THIS IS NOT A PROPERTY BOUNDARY SURVEY TO BE RECORDED WITH THE COUNTY SURVEYOR. BOUNDARIES MAY BE PRELIMINARY AND SHOULD BE CONFIRMED WITH THE STAMPING SURVEYOR PRIOR TO RELYING ON FOR DETAILED DESIGN OR CONSTRUCTION.
- 7. BUILDING FOOTPRINTS ARE MEASURED TO SIDING UNLESS NOTED OTHERWISE. CONTACT SURVEYOR WITH QUESTIONS REGARDING Building ties.
- 8. TREES WITH DIAMETER OF 6" AND GREATER ARE SHOWN. TREE DIAMETERS WERE MEASURED UTILIZING A DIAMETER TAPE AT BREAST HEIGHT. TREE INFORMATION IS SUBJECT TO CHANGE UPON ARBORIST INSPECTION.
- 9. WETLAND BOUNDARIES SHOWN WERE DELINEATED BY AKS ENGINEERING & FORESTRY, LLC. ON NOVEMBER 1, 2023. FEATURES WERE LOCATED USING A HANDHELD TRIMBLE GEO7X RECEIVER WITH SUBMETER ACCURACY, AND ARE CONSIDERED APPROXIMATE.
- 10. STRUCTURES FOUND WITHOUT PUBLIC UTILITIES MARKED. ADDITIONAL UNDERGROUND UTILITIES MAY BE IN AREA.

TREE TABLE			TREE TABLE			
TREE NUMBER	TYPE	DBH (IN.)	TREE NUMBER	TYPE	DBH (II	
10111	DECIDUOUS	9	10847	CONIFEROUS	7, 7	
10112	DECIDUOUS	9	10848	CONIFEROUS	15	
10119	DECIDUOUS	7	10849	CONIFEROUS	11	
10205	DECIDUOUS	10	10850	CONIFEROUS	12	
10415	DECIDUOUS	8	10851	CONIFEROUS	10	
10420	DECIDUOUS	6, 9, 10, 7	10852	CONIFEROUS	15	
10443	DECIDUOUS	6	10853	CONIFEROUS	6	
10444	DECIDUOUS	9	10854	CONIFEROUS	10	
10454	DECIDUOUS	6	10855	CONIFEROUS	12	
10467	DECIDUOUS	7	10856	DECIDUOUS	7	
10489	DECIDUOUS	9	10857	DECIDUOUS	6	
10490	DECIDUOUS	10	10858	DECIDUOUS	6	
10659	CONIFEROUS	11	10859	DECIDUOUS	6, 6	
10660	CONIFEROUS	8	10860	DECIDUOUS	6	
10675	CONIFEROUS	8	10861	DECIDUOUS	6	
10676	CONIFEROUS	6	10862	DECIDUOUS	7	
10677	CONIFEROUS	8	10863	CONIFEROUS	9	
10687	CONIFEROUS	11	10864	DECIDUOUS	8	
10701	CONIFEROUS	7	10865	DECIDUOUS	6	
10702	CONIFEROUS	9	10866	DECIDUOUS	7	
10703	CONIFEROUS	8	10867	DECIDUOUS	6, 6	
10704	CONIFEROUS	8	10868	DECIDUOUS	6	
10705	CONIFEROUS	6	10869	DECIDUOUS	6	
10713	DECIDUOUS	12	10870	CONIFEROUS	9, 7	
10844	CONIFEROUS	12	10871	DECIDUOUS	6	
10845	CONIFEROUS	10	10872	CONIFEROUS	56	
10846	CONIFEROUS	10	100000	DECIDUOUS	6	

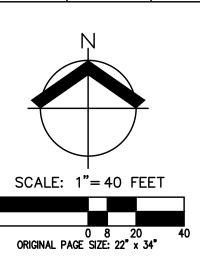

AKS 3700 KEIZE 503.4 WWW. **(5**)

COMMUNI

0 N O O

DATE: 01/24/2024 REGISTERED PROFESSIONAL LAND SURVEYOR DIGITALLY SIGNED 03/06/2024 2:07:45 PM OREGON NOVEMBER 9, 2021 JOSEPH F. SULLIVAN 86458LS


RENEWS: 6/30/2024

JOB NUMBER 10453


SHEET


C002

TL 402 TAX MAP 7 2W 19AD

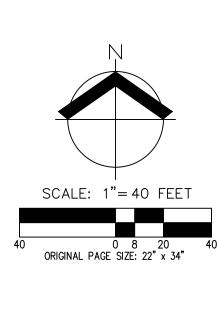

NICHOLA! STREET

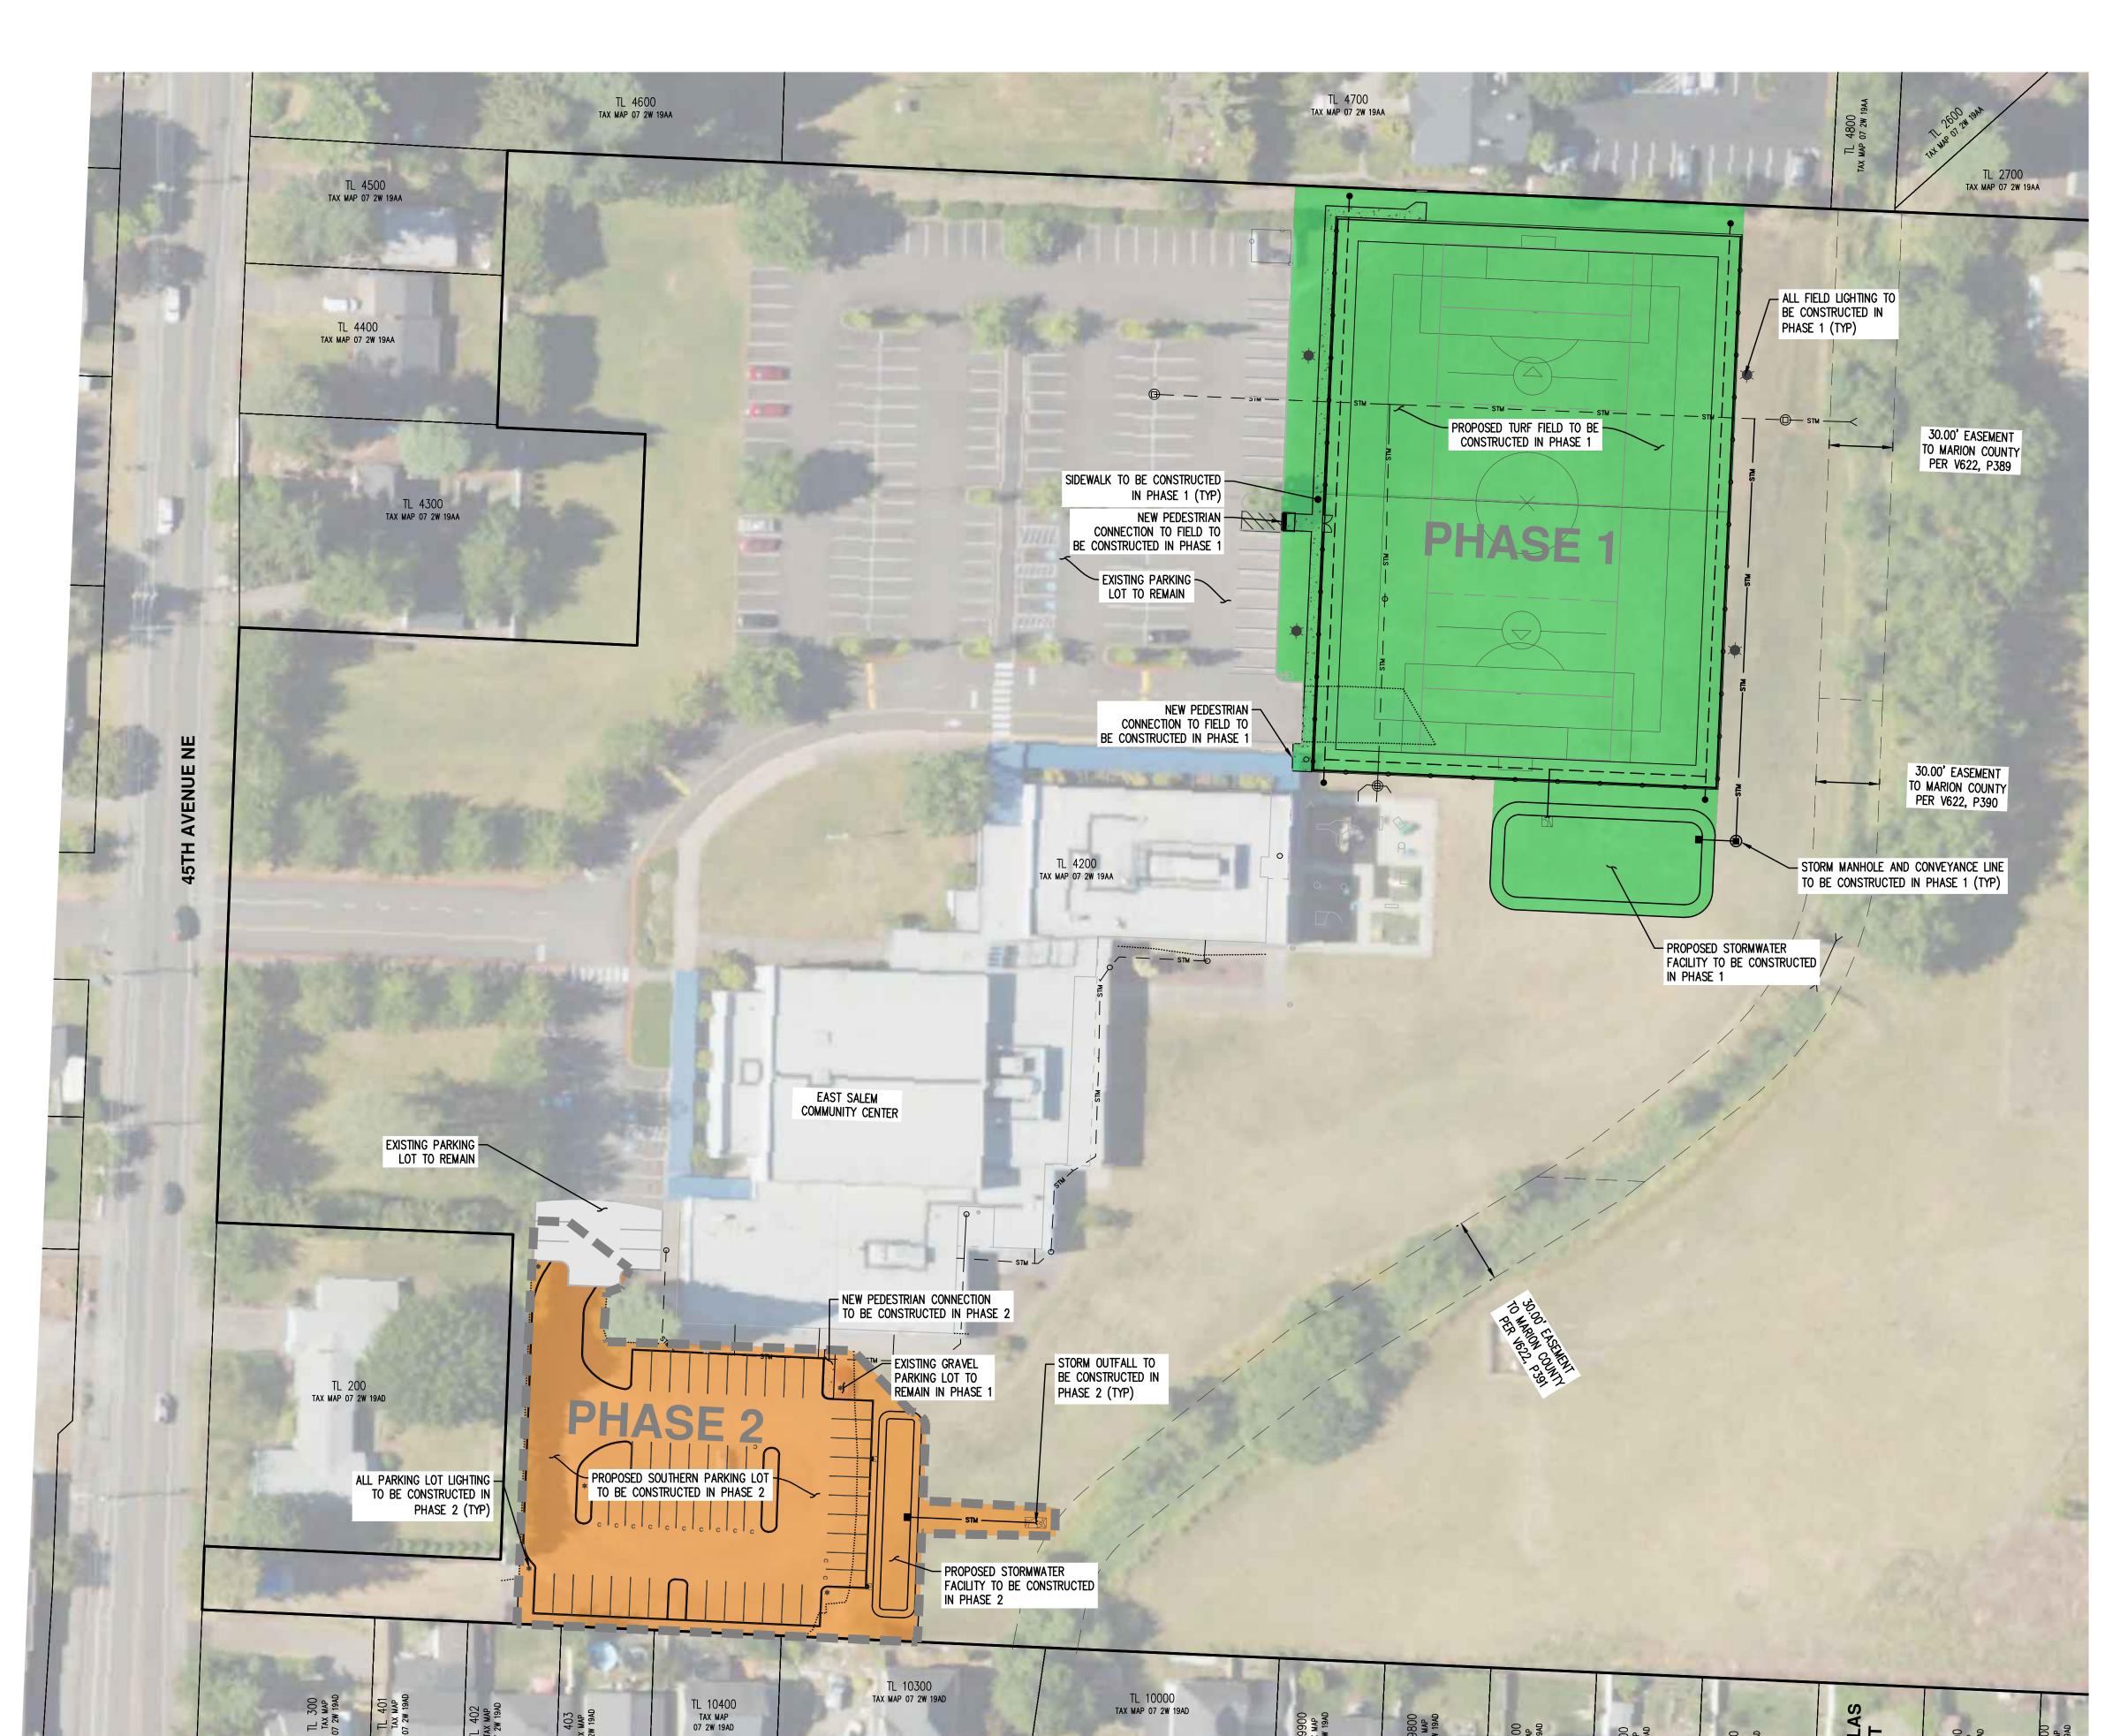

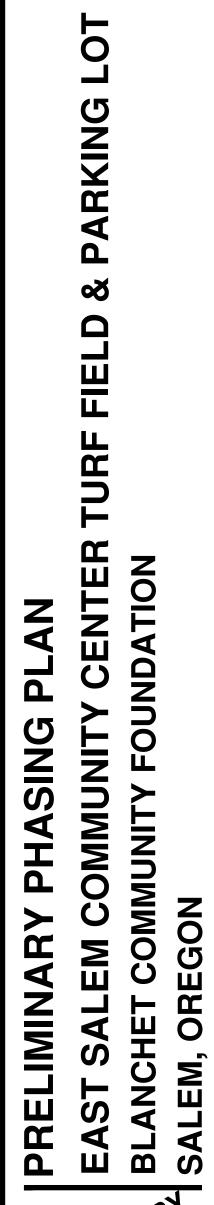

PRELIMINARY CONSTRUCTOR

JOB NUMBER:	10453
DATE:	05/08/2024
DESIGNED BY:	AMC
DRAWN BY:	ECR
CHECKED BY:	AMC

DEMOLITION KEYED NOTES: TR

- PROTECT AT ALL TIMES DURING CONSTRUCTION. ADJUST TO NEW FINISHED GRADE AS REQUIRED. ANY DAMAGE SHALL BE REPAIRED AT CONTRACTOR'S EXPENSE.
- R REMOVE AND HAUL OFF SITE FOR DISPOSAL UNLESS OTHERWISE NOTED

SITE KEYED NOTES:

- 1. 4" WIDE WHITE PARKING STRIPE
- 2. FIELD LIGHT
- 3. 4' TALL CHAIN LINK FENCE
- 4. PROPOSED SIDEWALK
- 5. 10" PERFORATED DRAIN
- CLEANOUT
- 7. STANDARD STORM MANHOLE
- 8. FLOW CONTROL STRUCTURE
- 9. CL 50 RIP RAP PAD
- 10. FLAT DRAINS AT 20' O.C AT AN ANGLE OF 45' FROM PERIMETER DRAIN
- 11. NOT USED
- 12. CURB INLET WITH RIPRAP SLOPE PROTECTION
- 13. SALVAGE WHEEL STOPS FOR REINSTALLATION WITH PARKING IMPROVEMENTS

CURB KEYED NOTES: (TR)

- TYPE 'C' CURB
- CONCRETE NAILER CURB

GENERAL NOTES:

1. STORMWATER FACILITIES ARE CONCEPTUAL AND ARE TO BE UPDATED PER FINAL SITE CONFIGURATION AND STORMWATER CALCULATIONS.

SITE INFORMATION (ON-SITE ONLY)

ADDRESS: 1850 45TH AVENUE NE, SALEM, OR 97305

ZONE: MULTIPLE FAMILY RESIDENTIAL (RM2) RESIDENTIAL AGRICULTURE (RA)

GROSS SITE AREA ±13.23 ACRES FIELD AREA 49,400 SF MAXIMUM ALLOWED PARKING: 221 STALLS 176 STALLS AMOUNT OF EXISTING PARKING:

AMOUNT OF EXISTING ADA PARKING: 7 STALLS EXISTING PARKING STALLS TO BE REMOVED: 3 STALLS

TOTAL ADDITIONAL PARKING PROVIDED: EXISTING STALLS: EXISTING STALLS TO BE REMOVED:

176 STALLS
3 STALLS
38 STALLS
13 STALLS
51 STALLS
224 STALLS **NEW STANDARD STALLS: NEW COMPACT PARKING STALLS:** TOTAL ADDITIONAL PARKING: TOTAL AMOUNT OF PARKING:

MAXIMUM ALLOWED COMPACT PARKING: 168 STALLS (75%)

PROPOSED LANDSCAPE AREA:

±3,100 SF (±15% OF PARKING LOT AREA) (DOES NOT INCLUDE CONCEPTUAL GSI STORMWATER FACILITY AREA)



SAWCUT

EXISTING TREE TO REMAIN EXISTING TREE TO BE REMOVED

EXISTING PAVEMENT/CONCRETE TO BE REMOVED

PROPOSED SIDEWALK

PROPOSED TURF FIELD

----○ ※ **8** *

PRELIMINARY CONSTRUCTOR CONSTRUCTOR JOB NUMBER: 05/08/2024 DESIGNED BY: DRAWN BY:

CING

SURFA

AND

SITE


PRELIMINARY

OMMUNITY

COMMUNITY

OREGON

BLANCH SALEM,

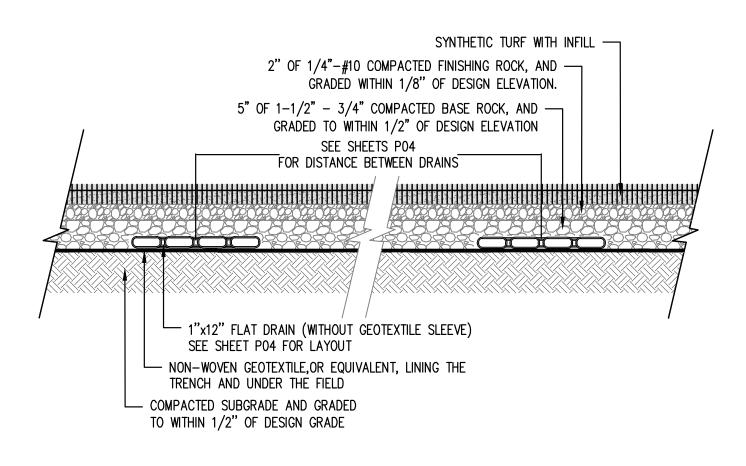


BASE SECTION DETAIL

SCALE: NTS

- SYNTHETIC TURF WITH INFILL APPROVED EQUAL, LINING THE ___ 1"x12" FLAT DRAIN (WITHOUT TRENCH AND UNDER THE FIELD GEOTEXTILE SLEEVE) 30505050505050505050505 PERF. DRAIN — TURN DOWN FLAT DRAIN TO COMPACTED SUBGRADE AND GRADED -PERIMETER DRAIN PERF PIPE TO WITHIN 1/2" OF DESIGN GRADE

NON-WOVEN GEOTEXTILE OR —

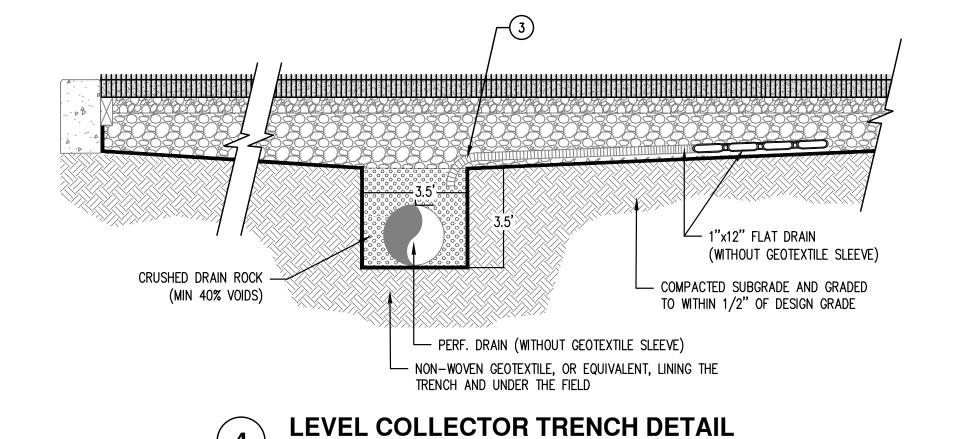


SCALE: NTS

FLAT DRAIN TO LEVEL COLLECTOR TRENCH DETAIL SCALE: NTS

AC PAVEMENT — (COMPACT TO MIN 91% OF MAX DENSITY PER RICE STANDARD METHOD) GRANULAR BASEROCK (COMPACT TO MIN 95% OF MAX DRY DENSITY PER AASHTO T-180) SUBGRADE (COMPACT TO MIN. 95% OF MAX DRY DENSITY PER AASHTO T-180) PAVEMENT & BASEROCK SECTIONS: PAVEMENT & BASEROCK SECTION PER GEOTECHNICAL REPORT

AC PAVEMENT SECTION DETAIL SCALE: NTS

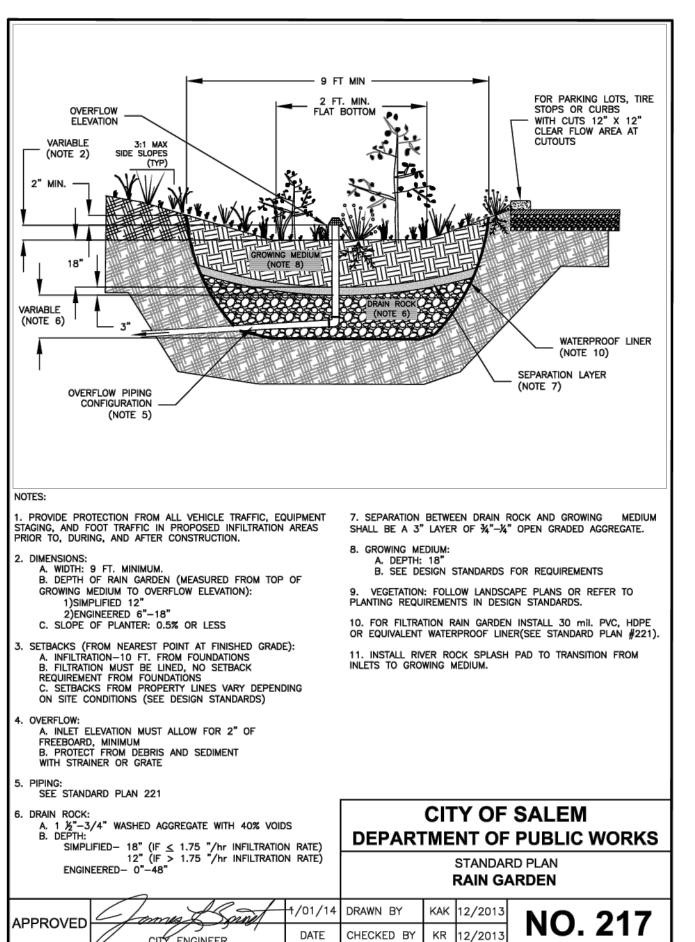

COS RAIN GARDEN DETAIL

SECTION TURF **PRELIMINAR**

O

JOB NUMBER: 05/08/2024 DESIGNED BY: DRAWN BY:



FIELD A AND UTILITY COMMUNITY GRADING COMMUNITY **PRELIMINARY** BLANCH SALEM,


PRELIMINARY CONSTRUCTOR 05/08/2024 DESIGNED BY: DRAWN BY:

OREGON

TREE PROTECTION KEYED NOTES: (#)

- ALL CONSTRUCTION ACTIVITIES IN PROXIMITY OF THE EXISTING ON-SITE SIGNIFICANT TREE SHALL REMAIN WITHIN THE EXISTING FOOTPRINT OF THE EXISTING PARKING LOT.
- ARBORIST OBSERVATION REQUIRED FOR CONSTRUCTION ACTIVITIES WITHIN THE TREE'S ASSUMED ROOT ZONE.

NO TREES OR NATIVE VEGETATION SHALL BE REMOVED FROM THE RIPARIAN CORRIDOR. PER SRC CHAPTER III, THE RIPARIAN CORRIDOR ALONG THIS STRETCH OF THE WEST FORK LITTLE PUDDING RIVER MEASURES 50' FROM THE TOP OF THE ADJACENT

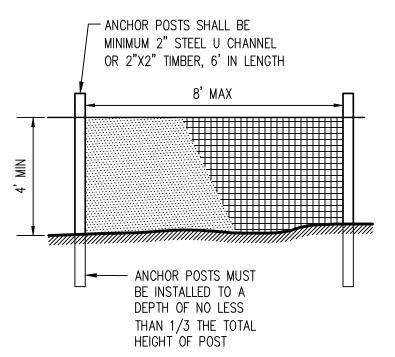

EXISTING GROUND CONTOUR (5 FT)

FINISHED GRADE CONTOUR (1 F

FINISHED GRADE CONTOUR (5 FT)

TREE PROTECTION FENCE (TREE PROTECTION AREA)


- 1. BLAZE ORANGE PLASTIC MESH FENCE FOR TREE PROTECTION DEVICE
- OR APPROVED EQUAL.

 2. AVOID DAMAGE TO TREE ROOT ZONE. DO NOT DAMAGE OR SEVER LARGE ROOTS WHEN INSTALLING POSTS.

 3. DEVICE SHALL BE MAINTAINED THROUGHOUT CONSTRUCTION.

TREE PROTECTION / CONSTRUCTION FENCE

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LEGEND EXISTING TREE TO REMAIN ASSUMED TREE ROOT ZONE (1-FT RADIUS PER 1-IN OF DBH)

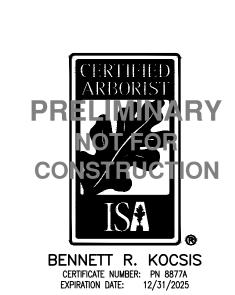CO.
JOB NUMBER
_DATE:
DESIGNED BY
DRAWN BY:

TION **ISERVA** NDATION CON TREE **PRELIMINARY**

AN

SALEM COMMUNITY

COMMUNITY OREGON BLANCH SALEM,

PRELIMINARY NOTFORTON-ONSTRUCTION

Detailed Tree Inventory for East Salem Community Center Turf Field & Parking Lot

AKS Job No. [10453] - Evaluation Date: 01/23/2024 - Evaluated by: BRK

Tree #	DBH (in.)	Avg. Crown Radius (ft)	Tree Species Common Name (Scientific name)	Comments	Health Rating*	Structure Rating**	Remov Preserv
10111	9	-	Deciduous	OFFSITE; Not evaluated by an arborist	-	-	Preser
10112	9	-	Deciduous	OFFSITE; Not evaluated by an arborist	-	-	Preser
10119	7	-	Deciduous	OFFSITE; Not evaluated by an arborist	-	-	Preser
10205	10	-	Deciduous	Not evaluated by an arborist	-	-	Presei
10415	8	-	Deciduous	Not evaluated by an arborist	-	-	Presei
10420	10,9,7,6	-	Deciduous	Not evaluated by an arborist	-	-	Prese
10443	6	-	Deciduous	Not evaluated by an arborist	-	-	Prese
10444	9	-	Deciduous	Not evaluated by an arborist	-	-	Prese
10454	6	-	Deciduous	Not evaluated by an arborist	-	-	Prese
10467	7	-	Deciduous	Not evaluated by an arborist	-	-	Prese
10489	9	-	Deciduous	Not evaluated by an arborist	-	-	Prese
10490	10	-	Deciduous	Not evaluated by an arborist	-	-	Prese
10659	11	-	Coniferous	Not evaluated by an arborist	-	-	Prese
10660	8	_	Coniferous	Not evaluated by an arborist	_	_	Presei
10675	8	_	Coniferous	Not evaluated by an arborist	_	_	Prese
10676	6	_	Coniferous	Not evaluated by an arborist		_	Prese
10677	8	_	Coniferous	Not evaluated by an arborist	_		Prese
10687	11	-	Coniferous	Not evaluated by an arborist	-	-	_
				· ·	-	-	Prese
10701	7	-	Coniferous	Not evaluated by an arborist	-	-	Prese
10702	9	-	Coniferous	Not evaluated by an arborist	-	-	Prese
10703	8	-	Coniferous	Not evaluated by an arborist	-	-	Prese
10704	8	-	Coniferous	Not evaluated by an arborist	-	-	Prese
10705	6	-	Coniferous	Not evaluated by an arborist	-	-	Prese
10713	12	-	Deciduous	Not evaluated by an arborist	-	-	Prese
10844	12	12	Western Redcedar (Thuja plicata)		1	1	Prese
10845	10	12	Western Redcedar (Thuja plicata)		1	1	Prese
10846	10	12	Western Redcedar (Thuja plicata)		1	1	Prese
10847	6,6	8	Western Redcedar (Thuja plicata)	Codominant base with included bark	1	2	Prese
10848	15	12	Western Redcedar (Thuja plicata)		1	1	Prese
10849	11	12	Western Redcedar (Thuja plicata)		1	1	Prese
10850	12	12	Western Redcedar (Thuja plicata)		1	1	Prese
10851	10	11	Western Redcedar (Thuja plicata)		1	1	Prese
10852	15	12	Western Redcedar (Thuja plicata)		1	1	Prese
10853	6	11	Western Redcedar (Thuja plicata)		1	1	Prese
10854	10	11	Western Redcedar (Thuja plicata)	Dead at very top	2	2	Prese
10855	12	10	Western Redcedar (Thuja plicata)	Codominant top	1	2	Prese
10856	7	6	Common Laurel (Prunus laurocerasus)		1	1	Prese
10857	6	7	Common Laurel (Prunus laurocerasus)		1	1	Prese
10858	6	7	Common Laurel (Prunus laurocerasus)		1	1	Prese
10859	6,6	8	Common Laurel (Prunus laurocerasus)		1	1	Prese
10860	6	6	Common Laurel (Prunus laurocerasus)		1	1	Prese
10861	6	8	Common Laurel (Prunus laurocerasus)		1	1	Prese
10861	7	8	Common Laurel (Prunus laurocerasus)				Prese
10862	9	8	Western Redcedar (Thuja plicata)	Dead top half; In decline	3	1	
			Common Laurel (Prunus laurocerasus)	beau top hall, ill decline		2	Prese
10864	8	7	· · · · · · · · · · · · · · · · · · ·		1	1	Prese
10865	6	6	Common Laurel (Prunus laurocerasus)		1 1	1	Prese
10866	7	6	Common Laurel (Prunus laurocerasus)		1	1	Prese
10867	6,6	7	Common Laurel (Prunus laurocerasus)		1	1	Prese
10868	6	8	Common Laurel (Prunus laurocerasus)		1	1	Prese
10869	6	5	Common Laurel (Prunus laurocerasus)		1	1	Prese
10870	9,7	7	Western Redcedar (Thuja plicata)	Dead top half; In decline	3	2	Prese
10871	6	6	Common Laurel (Prunus laurocerasus)		1	1	Prese
10872	56	16	Giant Sequoia (Sequoiadendron giganteum)	Good Condition, Large exposed roots (E); No evidence of significant root presence within footprint of existing parking lot	1	1	Prese
	6	8	English Walnut (Juglans regia)	OFFSITE; Topped; Many pruned limbs	2	3	Prese

Total # of Existing Trees Inventoried = 54

Total # of Existing Onsite Trees = 50

Total # of Existing Onsite Trees to be Preserved = 50
Total # of Existing Onsite Trees to be Removed = 0

Total # of Existing Offsite Trees = 4

Total # of Existing Offsite Trees to be Preserved = 4

Total # of Existing Offsite Trees to be Removed = 0

*Health Rati

- 1 = Good Health A tree that exhibits typical foliage, bark, and root characteristics, for its respective species, shows no signs of infection or infestation, and has a high level of vigor and vitality.
- 2 = Fair Health A tree that exhibits some abnormal health characteristics and/or shows some signs of infection or infestation, but may be reversed or abated with supplemental treatment.
- 3 = Poor Health A tree that is in significant decline, to the extent that supplemental treatment would not likely result in reversing or abating its decline.

**Structure Rating:

- 1 = Good Structure A tree that exhibits typical physical form characteristics, for its respective species, shows no signs of structural defects of the canopy, trunk, and/or root system.
- 2 = Fair Structure A tree that exhibits some abnormal physical form characteristics and/or some signs of structural defects, which reduce the structural integrity of the tree, but are not indicative of imminent physical failure, and may be corrected using arboricultural abatement methods.


Total # of Existing Line Trees = 0

3 = Poor Structure - A tree that exhibits extensively abnormal physical form characteristics and/or significant structural defects that substantially reduces the structural viability of the tree, cannot feasibly be abated, and are indicative of imminent physical failure.

Arborist Disclosure Statement:

Arborists are tree specialists who use their education, knowledge, training, and experience to examine trees, recommend measures to enhance the health of trees, and attempt to reduce the risk of living near trees. The Client and Jurisdiction may choose to accept or disregard the recommendations of the arborist, or seek additional advice. Arborists cannot detect every condition that could possibly lead to the structural failure of a tree. Trees are living organisms that fail in ways we do not fully understand. Conditions are often hidden within trees and below ground. Arborists cannot guarantee that a tree will be healthy or safe under all circumstances, or for a specified period of time. Likewise, remedial treatments, like medicine, cannot be guaranteed. Trees can be managed, but they cannot be controlled. To live near trees is to accept some degree of risk. The only way to eliminate all risk associated with trees is to eliminate all trees. Neither this author nor AKS Engineering & Forestry, LLC have assumed any responsibility for liability associated with the trees on or adjacent to this site.

At the completion of construction, all trees should once again be reviewed. Land clearing and removal of adjacent trees can expose previously unseen defects and otherwise healthy trees can be damaged during construction.

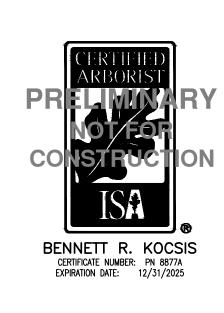



RELIMINARY CONSTRUCTION CONSTRUCTION

JOB NUMBER: 10453

DATE: 05/08/2024

DESIGNED BY: AMC

DRAWN BY: ECR

CHECKED BY: AMC

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	PRELIM	IINARY	PLANT SCHEDULE						
	TREES	QTY	BOTANICAL NAME	COMMON NAME	SIZE/CONTAINER	<u>SPACING</u>			
	\odot	7	ACER RUBRUM 'BOWHALL'	BOWHALL RED MAPLE	2" CAL. B&B	AS SHOWN			
		5	TILIA CORDATA	LITTLELEAF LINDEN	2" CAL. B&B	AS SHOWN			
,	SHRUBS_	<u>QTY</u>	BOTANICAL NAME	COMMON NAME	SIZE/CONTAINER	<u>SPACING</u>			
	(12	EUONYMUS ALATUS 'COMPACTUS'	COMPACT BURNING BUSH	2 GAL CONT.	48" o.c.			
	*	62	PENNISETUM ALOPECUROIDES 'HAMELN'	HAMELN FOUNTAIN GRASS	1 GAL CONT.	30" o.c.			
	⊙	98	PRUNUS LAUROCERASUS 'OTTO LUYKEN'	OTTO LUYKEN LAUREL	2 GAL CONT.	48" o.c.			
	☺	24	SPIRAEA X BUMALDA 'GOLDMOUND'	GOLDMOUND SPIREA	2 GAL CONT.	36" o.c.			
	•	56	VIBURNUM DAVIDII	DAVID VIBURNUM	2 GAL CONT.	36" o.c.			
	GROUND COVERS	QTY	BOTANICAL NAME	COMMON NAME	SIZE/CONTAINER	<u>SPACING</u>			
	+ + + + + + + +	221	ARCTOSTAPHYLOS UVA-URSI	KINNIKINNICK	1 GAL CONT.	30" o.c.			
	,	±12,365 SF	LAWN						
	<u>STORMWATER</u>	QTY	DESCRIPTION						
		17.000 CE	CTODAWATED FACILITY TO DE DECICALE	D DED OITY OF CALEM CTODA	AWATED CTANDADDC				

PRELIMINARY LANDSCAPE NOTES

1. PLANTS AND LANDSCAPING ARE PRELIMINARY AND SHOWN TO PORTRAY THE CHARACTER OF THE SITE. PLAN REVISIONS INCLUDING CHANGES TO PLANT SPECIES, SIZES, SPACING, QUANTITIES, ETC., DUE TO PLANT AVAILABILITY OR UNFORESEEN SITE CONDITIONS MAY BE APPROVED PRIOR TO INSTALLATION WHERE ALLOWED BY THE CITY OF SALEM'S DESIGN STANDARDS.

±7,098 SF STORMWATER FACILITY - TO BE DESIGNED PER CITY OF SALEM STORMWATER STANDARDS

- 2. ALL LANDSCAPE SHALL CONFORM TO THE CITY OF SALEM'S LANDSCAPE DESIGN STANDARDS AND TO THE AMERICAN STANDARDS FOR NURSERY STOCK (ANSI Z60.1, CURRENT EDITION) IN ALL WAYS; PLANT MATERIAL SHALL BE, UPON INSTALLATION, VIGOROUS AND WELL-BRANCHED, WITH HEALTHY AND WELL-FURNISHED ROOT SYSTEMS, FREE OF DISEASES, INSECT PESTS, AND INJURIES. PLANT IN ACCORDANCE WITH RECOGNIZED BEST PRACTICE INDUSTRY STANDARDS, SUCH AS THOSE ADOPTED BY THE OREGON LANDSCAPE CONTRACTOR'S BOARD (OLCB) AND THE AMERICAN HORTICULTURE INDUSTRY ASSOCIATION. FIELD ADJUST PLANT LOCATIONS AS NECESSARY TO AVOID CONFLICTS WITH UTILITIES, BUILDING OVERHANGS, ETC.
- 3. ALL LANDSCAPING SHALL BE INSTALLED AT THE TIME OF CONSTRUCTION UNLESS OTHERWISE APPROVED BY THE CITY OF SALEM DUE TO INCLEMENT WEATHER OR TEMPORARY SITE CONDITIONS.
- 4. A PERMANENT 'DESIGN-BUILD' UNDERGROUND OR DRIP IRRIGATION SYSTEM WITH A BACKFLOW DEVICE APPROVED BY THE CITY OF SALEM, SHALL BE PROVIDED FOR ALL NEW AND IMPROVED LANDSCAPED AREAS WITHIN THE PROJECT WORK AREA FOR THE ESTABLISHMENT AND LONG-TERM HEALTH OF PLANT MATERIAL
- 5. MULCH: APPLY 3" DEEP WELL-AGED DARK HEMLOCK OR FIR, MEDIUM GRIND, UNDER AND AROUND ALL PLANTS IN PLANTING BEDS, EXCLUDING STORMWATER FACILITIES AND DETENTION/CONVEYANCE AREAS.
- 6. ANY AREAS DISTURBED DURING CONSTRUCTION WITHIN THE PARKING LOT NOT SHOWING PROPOSED LANDSCAPE SHALL RECEIVE 3' OF BARK MULCH. ANY AREAS DISTURBED WITHIN THE LAWN AREA NOT SHOWING PROPOSED LANDSCAPE SHALL BE RESEEDED WITH LAWN SEED PER PLANT SCHEDULE.
- 7. SOIL PREPARATION: ALL PLANTING AREAS SHALL HAVE SUFFICIENT SOIL DEPTH AND FERTILITY TO SUPPORT HEALTHY PLANT GROWTH. EXISTING NATIVE SOIL OR STOCKPILED TOPSOIL STRIPPINGS MAY BE USED. TOPSOIL SHALL BE RICH DARK BROWN IN COLOR AND VOID OF ROOTS, PLANTS, WEEDS, SEEDS, SOD, STONES, CLAY LUMPS, ALKALI SALTS, DEBRIS, AND OTHER EXTRANEOUS MATERIALS HARMFUL TO PLANT GROWTH. IF IMPORTED TOPSOIL IS REQUIRED CONTRACTOR SHALL LOOSEN SUBSOIL TO A MINIMUM DEPTH OF 18" AND REMOVE ANY DEBRIS OR MATERIAL THAT MAY INHIBIT HEALTHY PLANT GROWTH PRIOR TO INSTALLATION OF TOPSOIL. IF NATIVE SOIL TO BE USED BECOMES COMPACTED DURING CONSTRUCTION ACTIVITY, CONTRACTOR SHALL LOOSEN TO A MINIMUM OF 12" AND AMEND EXISTING TOPSOIL WITH 2" OF VEGETATIVE COMPOST (SUCH AS COMPOSTED YARD WASTE) TILLED INTO THE SOIL. TOPSOIL SHALL BE PLACED OR WORKED IN FRIABLE (WORKABLE) CONDITION. SOIL SHALL NOT BE WORKED WHEN SATURATED TO PREVENT OVER-COMPACTION. FINISH GRADE OF ALL NEW PLANTINGS SHALL SEAMLESSLY MEET FINISH GRADE OF ANY EXISTING LANDSCAPE AREAS TO REMAIN AND AS INDICATED ON GRADING PLANS. PLANTING BED AREAS SHALL PROVIDE POSITIVE DRAINAGE AS INDICATED ON THE GRADING PLANS AND BE FREE OF HOLES, DIVOTS, OR HIGH/LOW SPOTS WHICH MAY CAUSE WATER TO COLLECT. BACKFILL PLANTING HOLES WITH A MIXTURE OF 1/3 ORGANIC MATERIAL, 1/3 TOPSOIL AND 1/3 SANDY LOAM.

TOTAL SITE PLANT UNITS (PU)							
PLANT MATERIAL	PU VALUE	QTY PROPOSED	TOTAL PU	PROPOSED PU			
1.5" CAL. SHADE TREES	10 PU	12	120 PU				
6' HT. CONIFER TREE	5 PU	0	0 PU				
1.5" CAL. ORNAMENTAL TREE	2 PU	0	0 PU	TREE PU: 120			
3G LARGE SHRUB	2 PU	0	0 PU				
1G SMALL SHRUB	1 PU	190	190 PU				
GROUNDCOVER	1 PU/50 SF	13,356 SF	267 PU	SHRUB PU: 457			

LANDSCAPE INFORMATION (ON-SITE ONLY)

TOTAL IMPERVIOUS AREA (PARKING LOT ONLY): ±18,878 SF CONCEPTUAL GSI STORMWATER FACILITY AREA: ±1,920 SF (±10% OF PARKING LOT IMPERVIOUS AREA)

PROPOSED LANDSCAPE AREA:

±3,100 SF (±15% OF PARKING LOT AREA) (DOES NOT INCLUDE CONCEPTUAL GSI STORMWATER FACILITY AREA)

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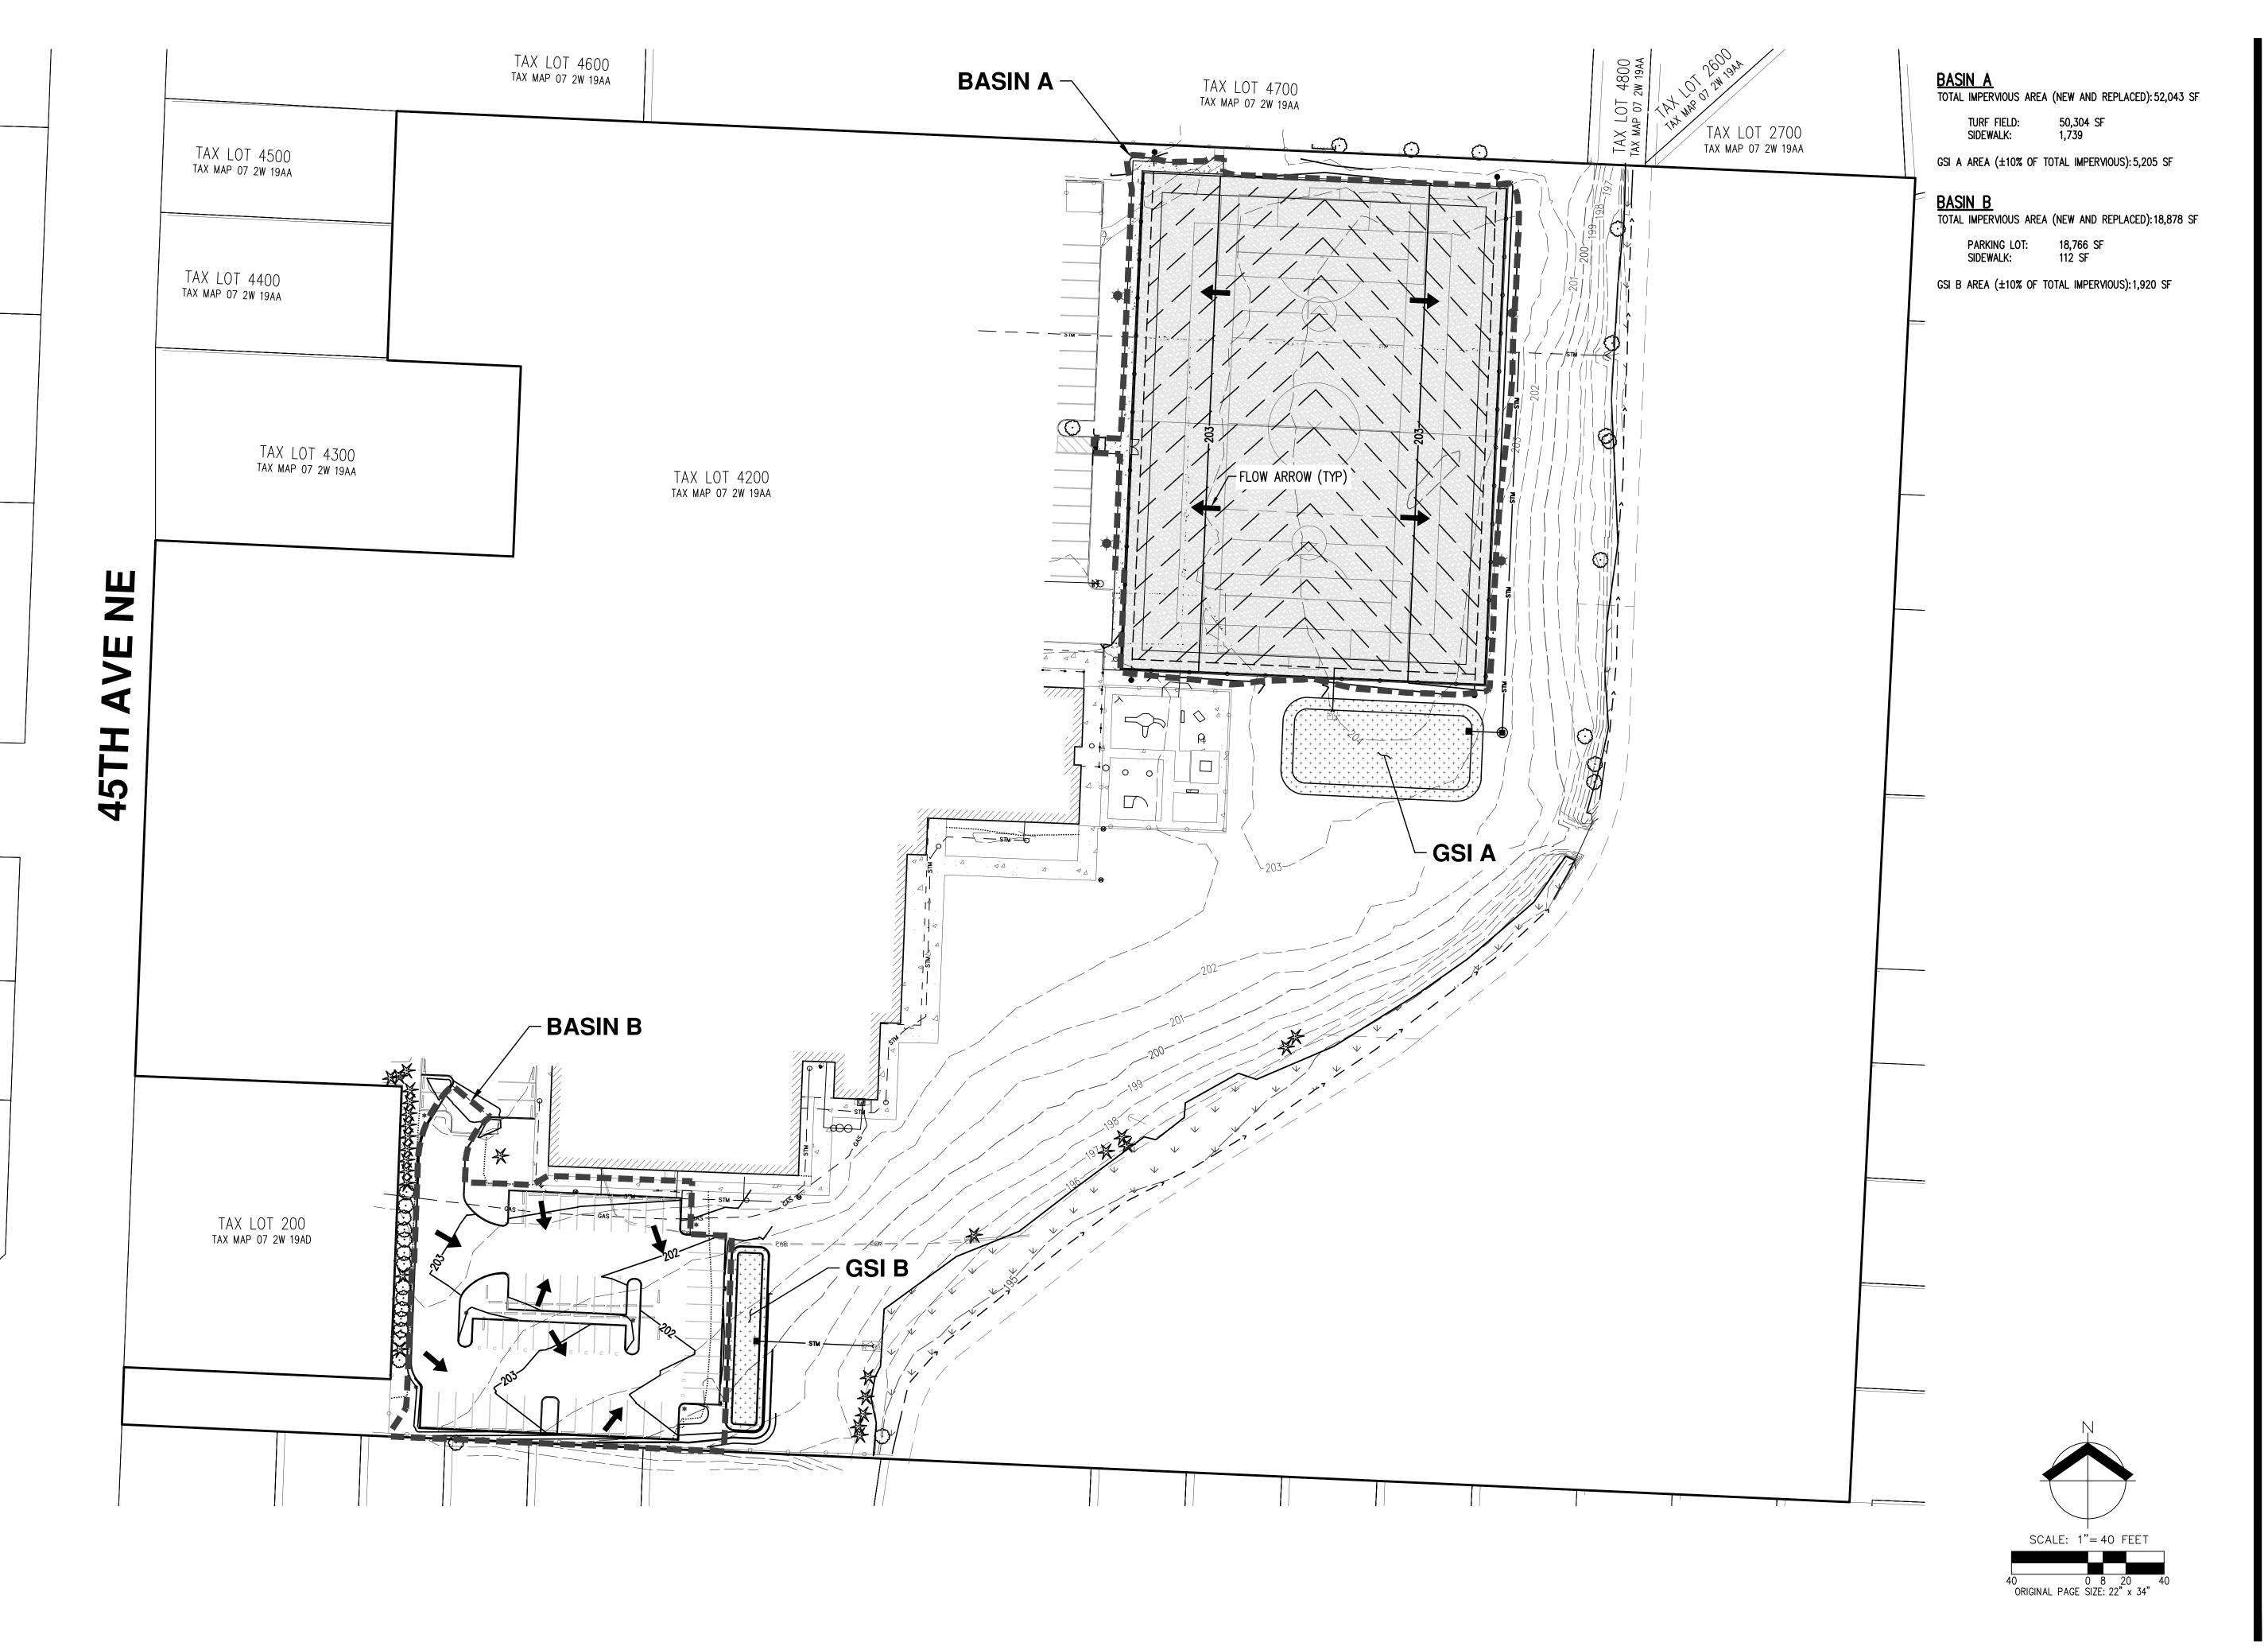
DESIGNED BY:

CHECKED BY:

DRAWN BY:

TEB

TEB



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ENGINEERING · SURVEYING · NATURAL RESOUR
FORESTRY · PLANNING · LANDSCAPE ARCHITECTI

| NON-DISCRETIONARY STORMWATER SITE | EAST SALEM COMMUNITY CENTER TURF F | BLANCHET COMMUNITY FOUNDATION | SALEM, OREGON

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PELIMINAR PORTION CONSTRUCTION CONSTRUCTION 10453

JOB NUMBER: 10453

DATE: 05/08/2024

DESIGNED BY: AMC

DRAWN BY: ECR

CHECKED BY: AMC